


Verify All Dimensions Prior to Construction - Do not scale

NOTES:

- CONTRACTOR SHALL REFER TO THE PIPING ISOMETRIC DRAWINGS FOR DIMENSIONAL INFORMATION ON FIELD INSTALLED PIPING. CONTRACTOR SHALL INSTALL PIPE PER VENDOR INSTALLATION PROCEDURES.
- ELEVATIONS ARE BASED ON FINISH FLOOR IN TURBINE HALL. BENCHMARK EL=2005.1m MSL.
- UNDERGROUND STAINLESS STEEL U-SEAL LINE IS NOT SHOWN FOR CLARITY. REFER TO PIPING ISOMETRIC DRAWING FOR ROUTING. TO BE INSTALLED AFTER FRP LINES AND BEFORE ROAD/DRAINAGE STRUCTURES.

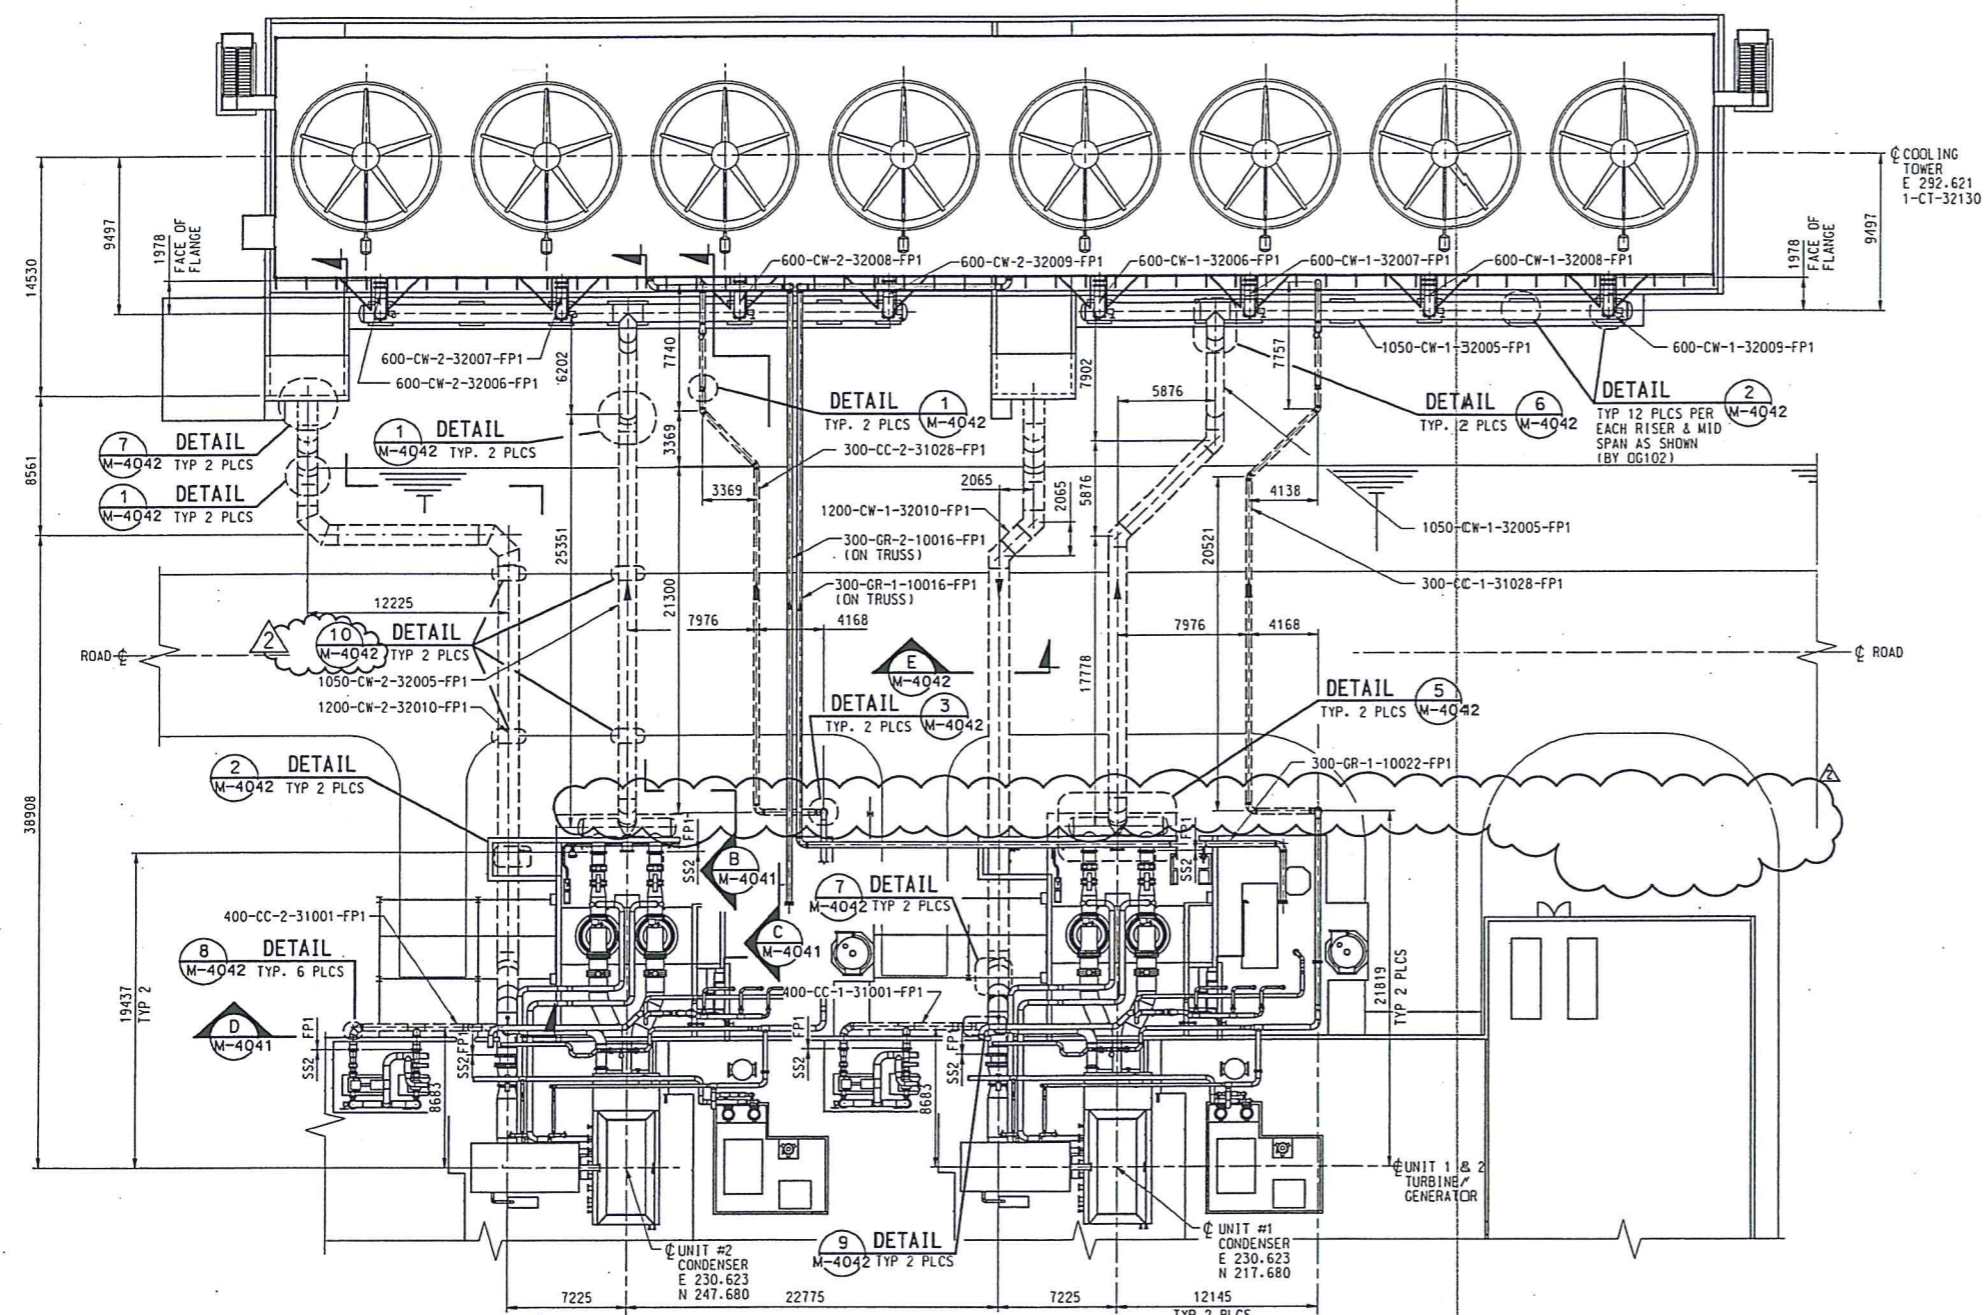

2	REVISED PER DCN 11. 20	CEA	CFC	TDD	12/19/03
1	CHGD. SKM DNG NO. TO PREV. NO.	CEA	CFC	TDD	12/19/03
0	ISSUED FOR CONSTRUCTION	CEA	CFC	TDD	12/15/03

Rev Reason By Chk App. Date

Client



The Kenya Electricity Generating Company Ltd.
 Sime Plaza, Kolobot Road, Parklands
 PO Box 47938, Nairobi, Kenya
 Telephone 254-2-248333, Fax 254-2-248344

Org. No. 12571-102-M-PP-4040

Consultants

SINCLAIR KNIGHT MERZ
 Sinclair Knight Merz Ltd.

Sub-Consultants

Howard Humphreys (Kenya) Ltd. **PB**
 Consulting Engineers PB Kennedy & Donkin Limited


Contractor

MITSUBISHI HEAVY INDUSTRIES, LTD.
 NAGASAKI SHIPYARD AND MACHINERY WORKS

LAND TURBINE DESIGNING SEC.	ORDER	ITEM
POWER PLANT ENG. DEPT.		

Scale 1:200
 Designed: [] Checked: []
 Drawn: [] Approved: []

MITSUBISHI ELECTRIC CORPORATION
 ENERGY AND INDUSTRIAL SYSTEMS CENTER



3540 GLENBROOK DRIVE HALEY, IDAHO 83333

Scale 1:200
 Designer: JAB Checked: TOD
 Drawn: CEA Approved: TOD

Job


OLKARIA II GEOTHERMAL POWER PROJECT
 CONTRACT OG102: POWER STATION
 MECHANICAL & ELECTRICAL PLANT

Title

UNDERGROUND FRP PIPING PLAN

Org. No. M-4040 Rev 2

PEI INTERNAL DISCIPLINE REVIEW
 MECH CAD
 THIS DRAWING WAS PREPARED BY POWER ENGINEERS, INC. FOR A SPECIFIC PROJECT. IT IS TO BE USED ONLY FOR THE PROJECT AND UNDER THE SUPERVISION OF THE PROJECT ENGINEER. ANY INFORMATION CONTAINED IN THIS DRAWING FOR ANY INFORMATION IS FOR INFORMATION ONLY AND IS NOT TO BE USED FOR ANY OTHER PURPOSE. ANY REVISIONS SHALL BE INDICATED BY A REVISION TABLE AND SHALL BE APPROVED BY THE PROJECT ENGINEER.

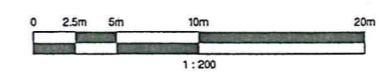

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